CITY OF MADISON

CITY ENGINEERING DIVISION DEPARTMENT OF PUBLIC WORKS PLAN OF PROPOSED IMPROVEMENT

INDEX OF SHEETS

SHEET NO. 1

SHEET NO. P-1 SHEET NO. EI – E9

SHEET NO. PMI – PM2 PERMENANT PAVEMENT MARKINGS

TITLE

SIDEWALK & STREET PLAN ELECTRICAL PLAN

AMERICAN PARKWAY & AMERICAN FAMILY DRIVE TRAFFIC SIGNAL ASSESSMENT DISTRICT

CONVENTIONAL SIGNS FIELD VERIFY ALL UTILITY LOCATIONS GASSTORM SEWER SANITARY SEWER WATER BURIED ELECTRIC OVERHEAD ELECTRIC POWER POLE ADA COMPLIANT RAMP W/ DETECTABLE WARNING FIELD COMBUSTIBLE FLUIDS


NOTES:

ALL GUTTERS SHALL DRAIN WITH A MINIMUM GRADE OF 0.50% TOWARD STORM SEWER INLETS.

SIDEWALK RAMPS AND CURB THRU SIDEWALK RAMPS SHALL HAVE A MAXIMUM SLOPE OF I" PER 12". SIDEWALK AND CURB RAMPS SHALL BE CONSTRUCTED WITH A SIDE SLOPE OF 1.50%. SIDEWALK SHALL HAVE A MINIMUM LONGITUDINAL SLOPE OF 0.50% AND A MAXIMUM LONGITUDINAL SLOPE OF 5.00% EXCEPT WHERE STREET GRADES EXCEED 5.00%.

EARTH WORK SUMMARY:

EXCAVATION CUT (MEASURED PLAN QUANTITY) .. ESTIMATED UNDISTRIBUTED UNDERCUT TOTAL UNCLASSIFIED EXCAVATION CUT

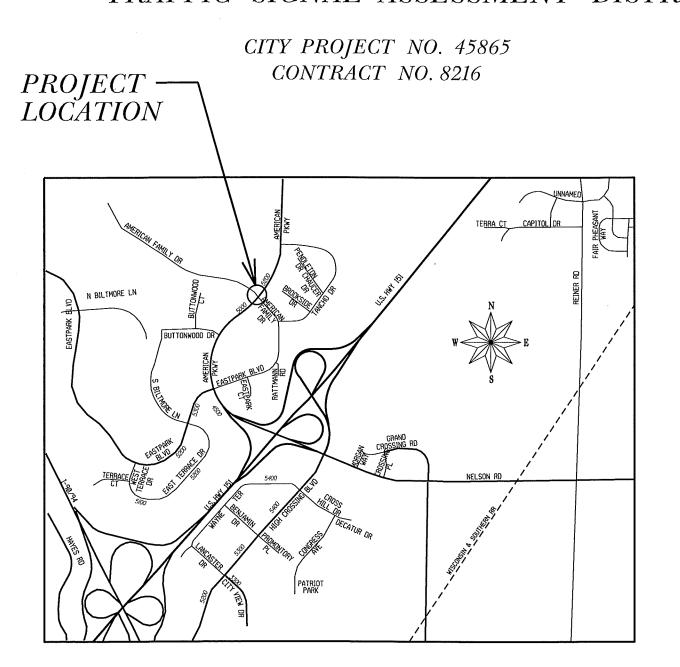


PUBLIC IMPROVEMENT PROJECT APPROVED

IUNE 5, 2018

BY THE COMMON COUNCIL OF MADISON, WISCONSIN

PUBLIC IMPROVEMENT DESIGN APPROVED BY:


SIDEWALK GRADES DESIGNED BY:

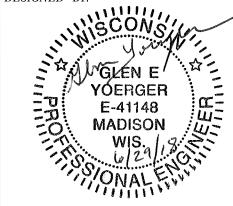

ELECTRICAL DESIGNED E

PAVEMENT MARKINGS DESIGNED BY:



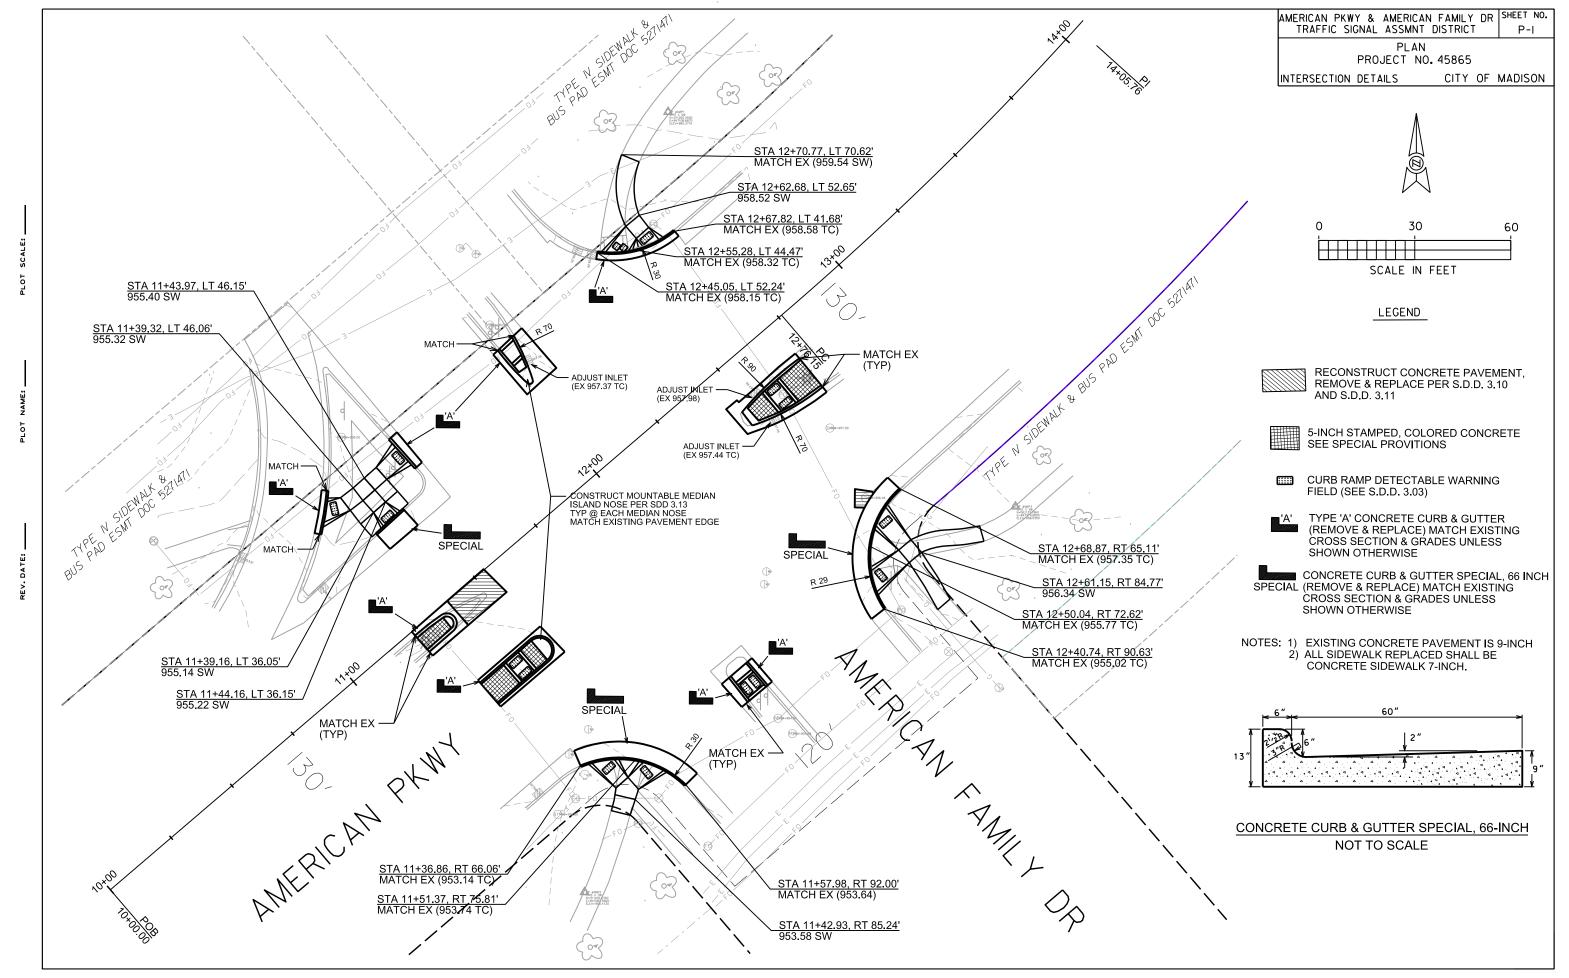

SHEET NO.

ELECTRICAL PLANS

CITY OF MADISON

JLS 6/28/2018
REV. JLS 8/30/18


GENERAL ELECTRIC NOTES:


- 1. ALL LOCATIONS ARE APPROXIMATE, THE TRAFFIC ENGINEER SHALL APPROVE FINAL LOCATIONS, INCLUDING SETBACK, IN THE FIELD AFTER CONTRACTOR SURVEYS STAKING.
 THE CONTRACTOR SHALL NOTIFY JERRY SCHIPPA (608 267-1969) CITY TRAFFIC ENGINEERING, AT LEAST 24-HOURS IN ADVANCE OF NEEDING CONDUIT OR BASE LOCATIONS MARKED.
- 2. BASES INSTALLED IN TERRACE SHALL BE 4' FROM FACE OF CURB UNLESS OTHERWISE NOTED, SUBJECT TO NOTE 1 ABOVE.
- 3. THE CONTRACTOR SHALL DO ALL WORK IN ACCORDANCE WITH "CITY OF MADISON STANDARD SPECIFICATIONS FOR PUBLIC WORKS CONSTRUCTION, 2018 EDITION" AND ALL ADDENDUMS THERETO. ALL CONDUIT SHALL BE PVC, SCHEDULE 80 UNDER PAVEMENT OR SCHEDULE 40 OTHERWISE. PULL WIRE REQUIRED AS PER STANDARD SPECIFICATIONS.
- 4. THE CONTRACTOR SHALL CALL TROY VANT (608 266-9031) AT THE TRAFFIC ENGINEERING SHOP AT LEAST 24-HOURS IN ADVANCE OF POURING BASES, INSTALLING HANDHOLES OR BURYING CONDUIT TO ARRANGE FOR INSPECTION.
- 5. ANY WORK COMPLETED WITHOUT INSPECTION IS SUBJECT TO REJECTION.
- 6. EXISTING STREETLIGHTS SHALL BE IN SERVICE EACH AND EVERY NIGHT.
- 7. TRAVEL LANE CLOSURES SHALL ONLY OCCUR ON WEEKDAYS BETWEEN 9:00 AM AND 4:00 PM AND ANYTIME ON WEEKENDS. ALL LANE CLOSURES OF AMERICAN PARKWAY SHALL REQUIRE AN ELECTRONIC, FLASHING ARROWBOARD. FLASHING ARROWBOARD COST INCLUDED IN BID ITEM 10701 TRAFFIC CONTROL.
- 8 ALL SIGNING AND BARRICADING SHALL CONFORM WITH THE FEDERAL HIGHWAYS ADMINISTRATIONS "MANUAL ON UNIFORM TRAFFIC CONTROL DEVICES" (MUTCD) AND THE CITY OF MADISON STANDARD SPECIFICATIONS FOR SIDEWALK AND BIKEWAY CLOSURES AND THE STATE OF WISCONSIN STANDARD DETAIL DRAWING S.D.D. 1503.
- 9. THE CONTRACTOR SHALL ARRANGE FOR PICK UP OF THE FOLLOWING CITY FURNISHED MATERIALS, WHICH SHOULD BE ARRANGED FOR PICKUP BY CALLING DENNIS ROWE, TRAFFIC ENGINEERING SHOP, (608 266-9034) 1120 SAYLE ST., AT LEAST 24-HOURS PRIOR TO NEEDING MATERIALS:
 - (16) 1 1/4" X 48" ANCHOR BOLTS
 - (12) 1" X 40" ANCHOR BOLTS
 - (12) 3/4" X 19" ANCHOR BOLTS
- 10. THE CONTRACTOR SHALL PROVIDE ANCHOR BOLTS FOR TYPE 10 BASES.
- 11. THE CONTRACTOR SHALL COORDINATE WITH TROY VANT, TRAFFIC ENGINEERING SHOP (608 266-9031) PRIOR TO REMOVING BASES OR HANDHOLES. EXISTING FIBER OPTIC CONDUIT SHALL BE MAINTAINED DURING CONSTRUCTION. EXISTING FIBER IS LOCATED IN THE AMERICAN PARKWAY MEDIAN, CROSSING THE EB LANES OF AMERICAN PARKWAY, CROSSING THE NB LANES OF AMERICAN PARKWAY. AND CONTINUING EAST ALONG THE NORTH TERRACE OF AMERICAN PARKWAY.


PLC

ZEV. DATE

OF MADISON, TRAFFIC ENG. DIV.

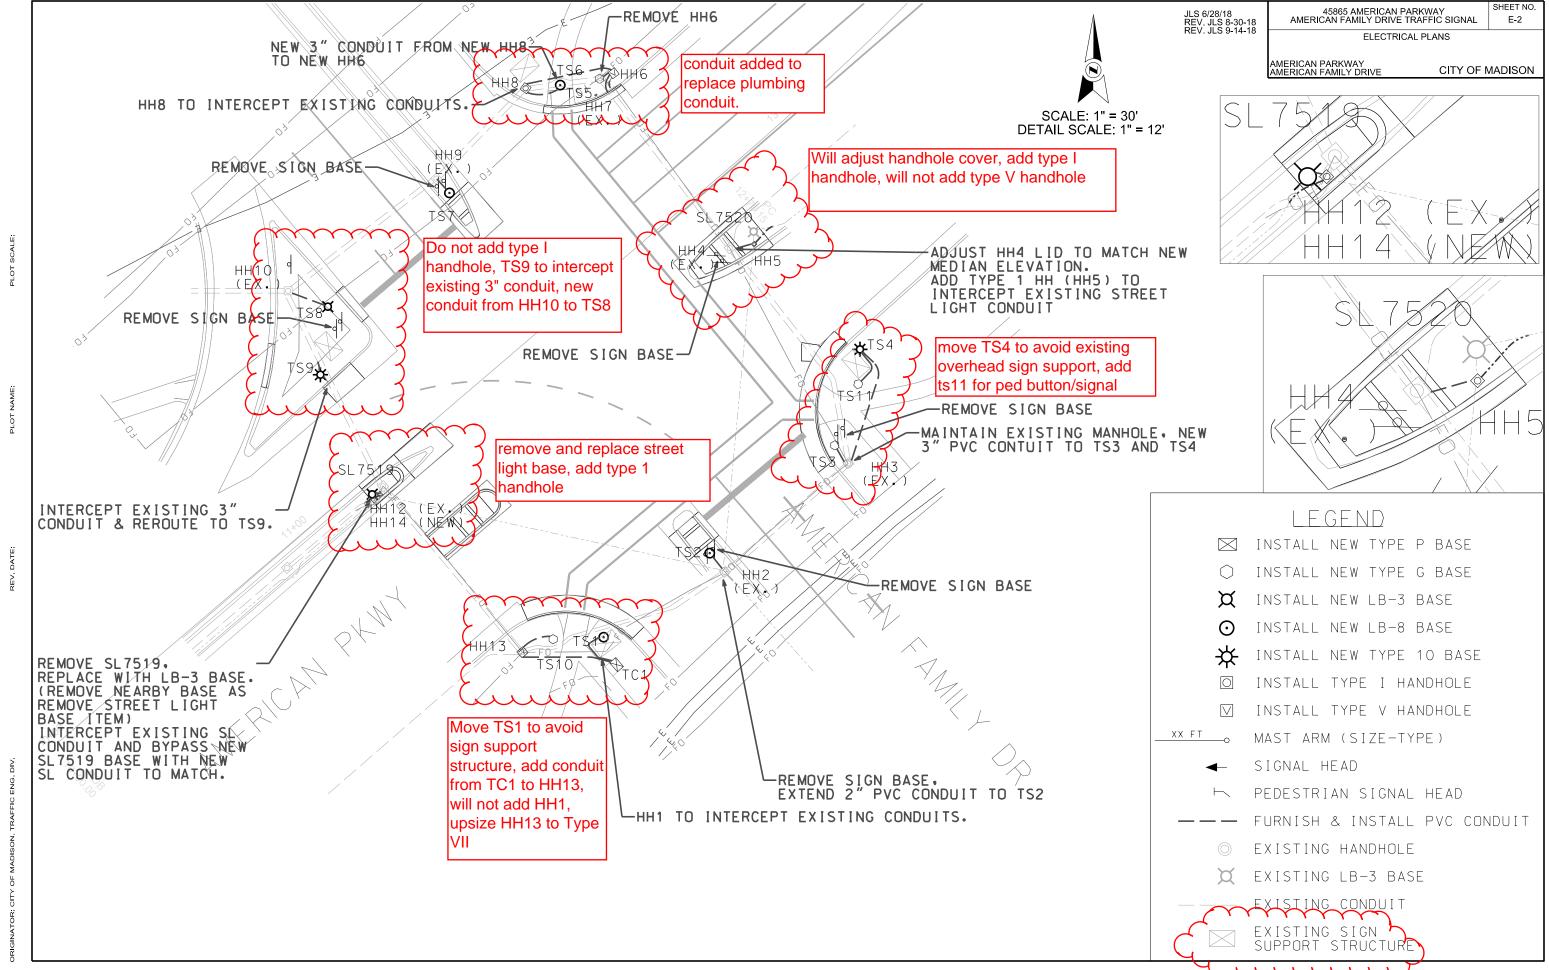


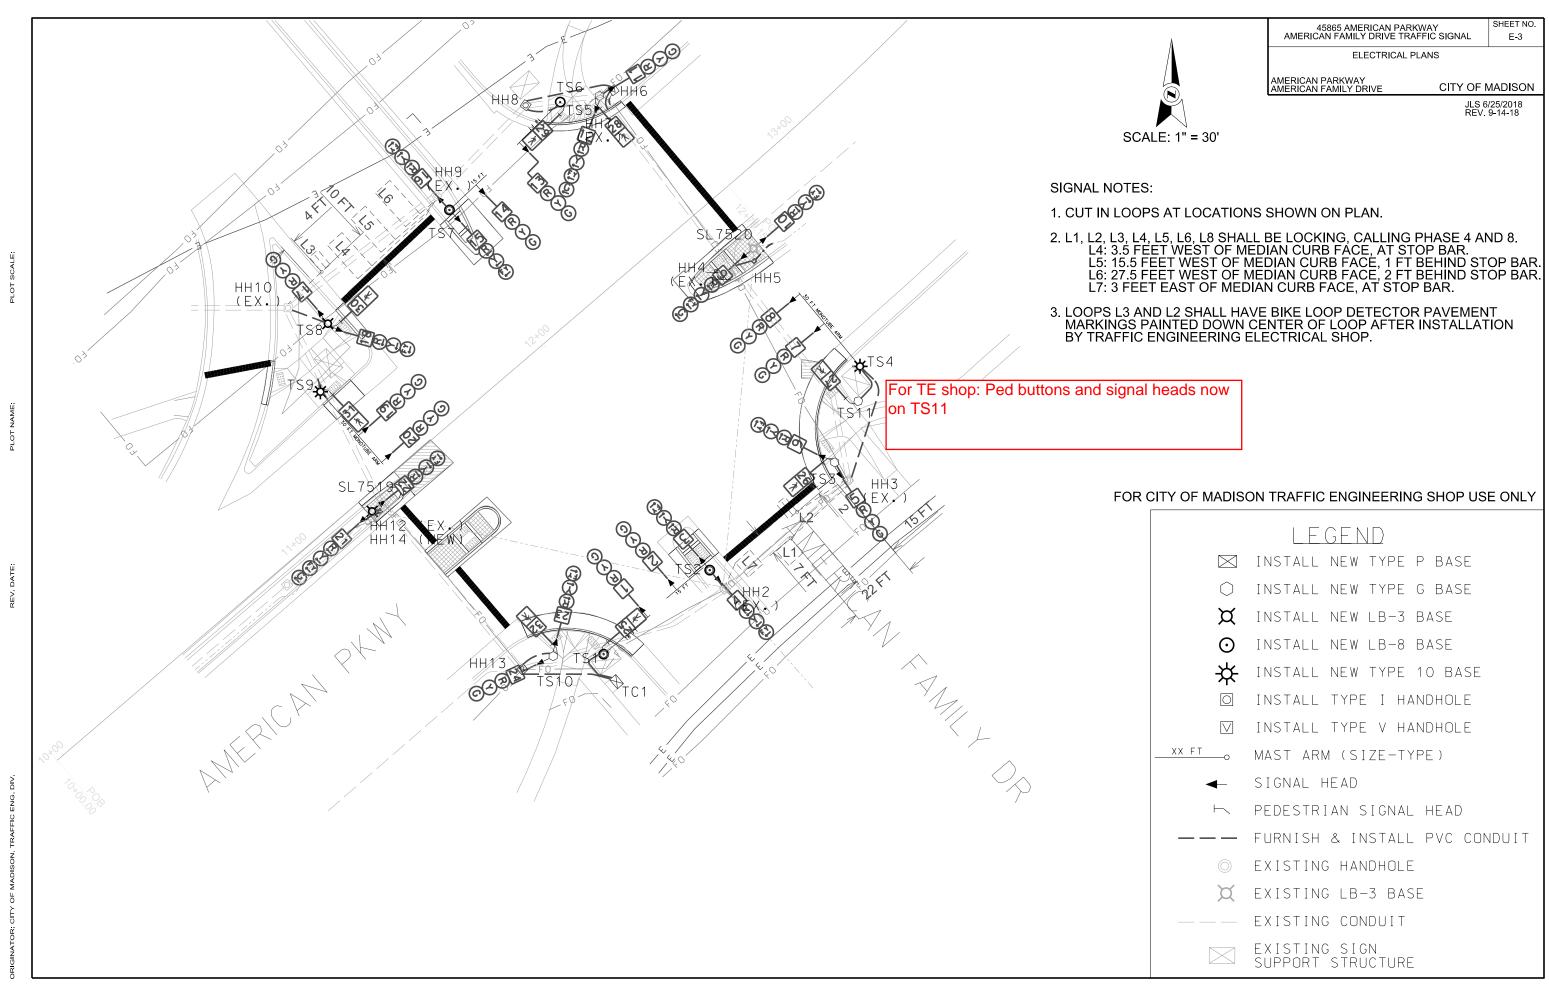

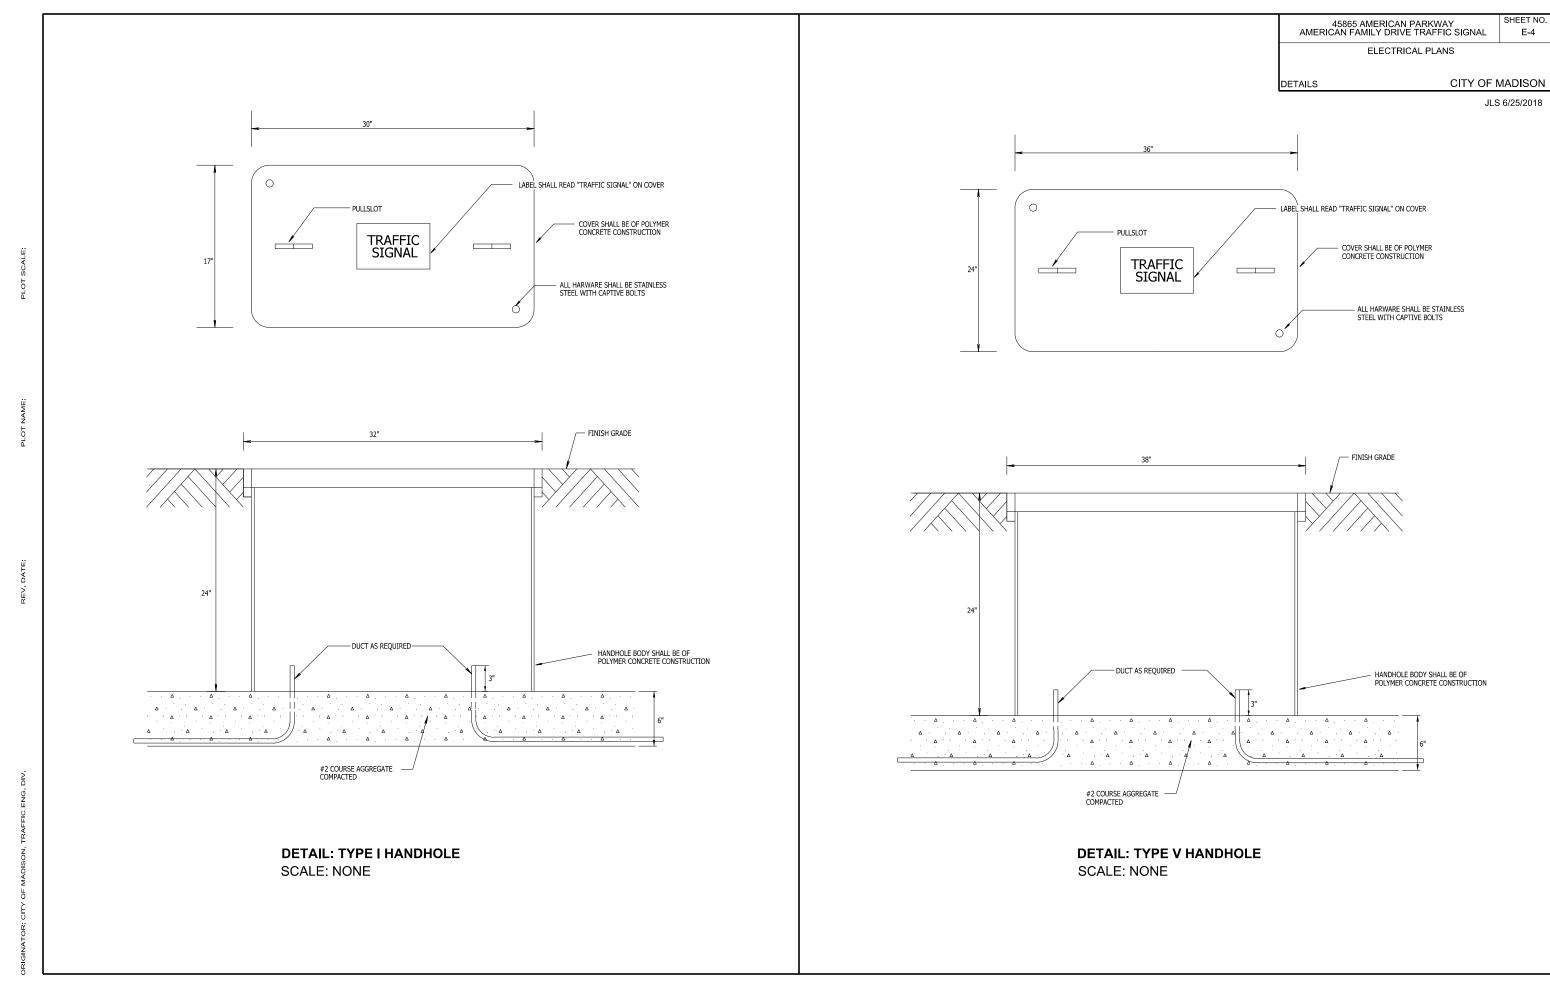

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DATE: \$\$...plottlngdate...\$\$

CONTROL CABINET		IMEN	ISION	IS	C.Y. CONCRETE	
BASE TYPE	L	W	J	K	(APPROX.)	
TYPE M	40''	30''	12''	20"	.823	
TYPE P	48''	30''	16''	24"	1.179	
TYPE M MODIFIED	-	-	-	-	-	
TYPE P MODIFIED	_	-	-	-	-	
TYPE OTHER			=		-	

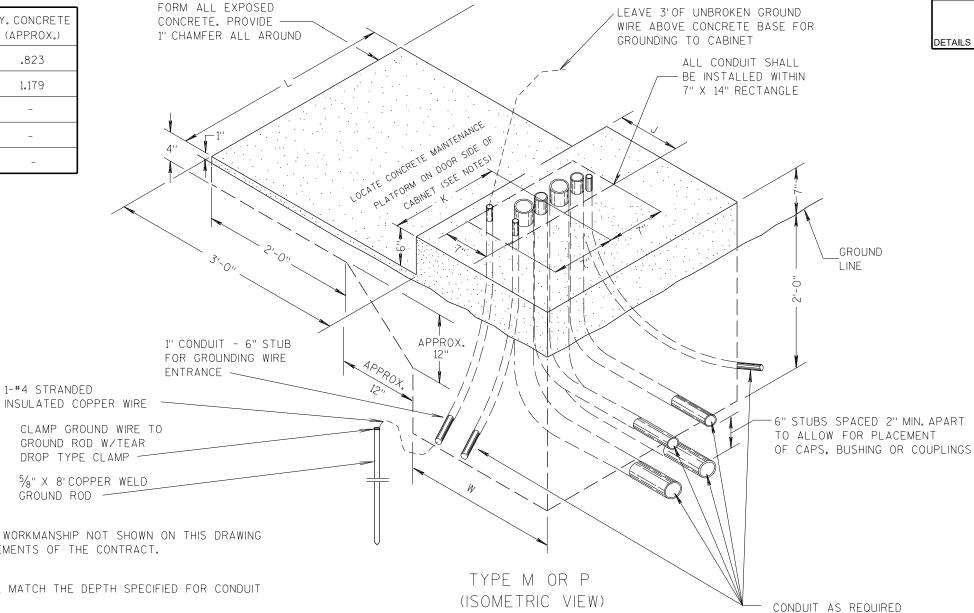

SHEET NO.

E-5

CITY OF MADISON JLS 6/25/2018

45865 AMERICAN PARKWAY AMERICAN FAMILY DRIVE TRAFFIC SIGNAL

ELECTRICAL PLANS

GENERAL NOTES

DETAILS OF CONSTRUCTION, MATERIALS AND WORKMANSHIP NOT SHOWN ON THIS DRAWING SHALL CONFORM TO THE PERTINENT REQUIREMENTS OF THE CONTRACT.

ALL CONDUIT SHALL BE PVC, SCHEDULE 40

DEPTH OF CONDUIT EXITING THE BASE SHALL MATCH THE DEPTH SPECIFIED FOR CONDUIT INSTALLATION.

ANY EXCEPTION TO THE MAXIMUM DEPTH SHALL BE ONLY WITH THE WRITTEN APPROVAL OF THE ENGINEER.

CONTROL CABINET BASE TOP SURFACES SHALL BE TROWEL FINISHED AND LEVEL.

MAINTENANCE PLATFORM SHALL NOT BE INSTALLED WHEN THE SURROUNDING AREA IS PAVED.

MINIMUM BENDING RADIUS OF CONDUIT = 6 X THE DIAMETER.

ALL CONDUIT ENDS AT THE TOP OF CONCRETE BASES SHALL BE CAPPED OR PLUGGED IMMEDIATELY AFTER PLACEMENT AND BEFORE CONCRETE IS POURED. CONDUITS IN WHICH WIRE OR CABLE IS NOT BEING INSTALLED SHALL REMAIN CAPPED OR PLUGGED.

CONCRETE FORM DEPTH BELOW FINISHED GRADE SHALL BE 6" MINIMUM. CONCRETE FORMS SHALL BE REMOVED AFTER CONCRETE HAS SET.

CONDUITS SHALL EXIT THE BASE IN THE DIRECTION OF THE STRUCTURE IT IS TERMINATING INTO.

MAINTENANCE PLATFORM SIZE MAY VARY ON ACCOUNT OF CONDITIONS. VERIFY THE MAINTENANCE PLATFORM SIZE WITH ENGINEER PRIOR TO POURING BASE.

CONCRETE CONTROL CABINET BASES

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DATE: \$\$...plottIngdate...\$\$


45865 AMERICAN PARKWAY
AMERICAN FAMILY DRIVE TRAFFIC SIGNAL


ELECTRICAL PLANS

DETAILS

CITY OF MADISON

JLS 6/25/2018

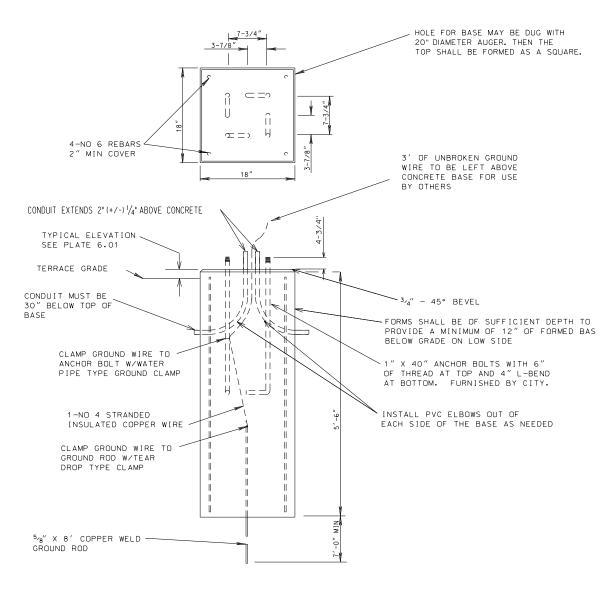

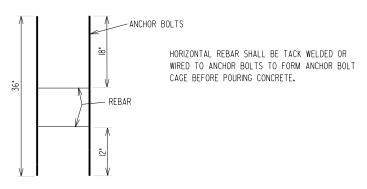

DETAIL: LB-3 BASE SCALE: NONE


ELECTRICAL PLANS

DETAILS

CITY OF MADISON JLS 6/25/2018


SHEET NO.

E-7

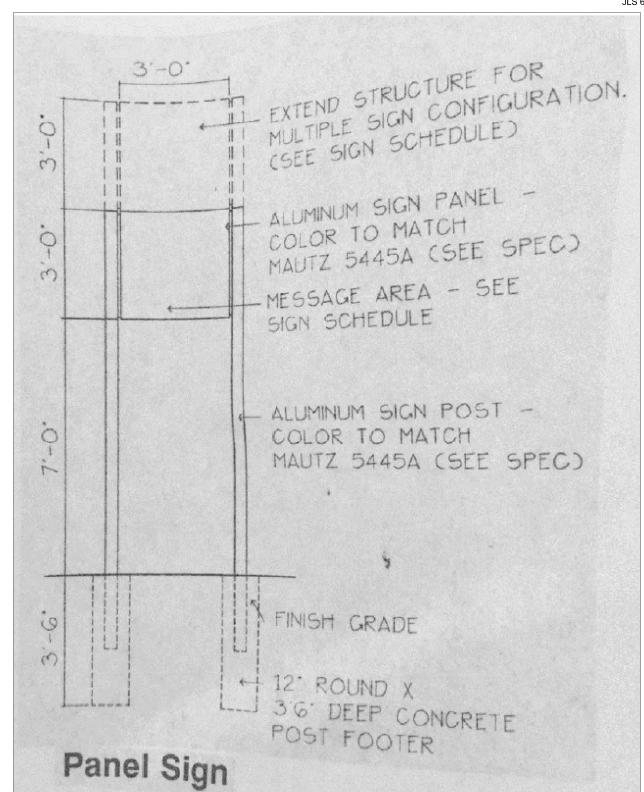

DETAIL: REMOVE SIGN BASE SCALE: NONE

HORIZONTAL REBAR SHALL BE TACK WELDED OR WIRED TO ANCHOR BOLTS TO FORM ANCHOR BOLT

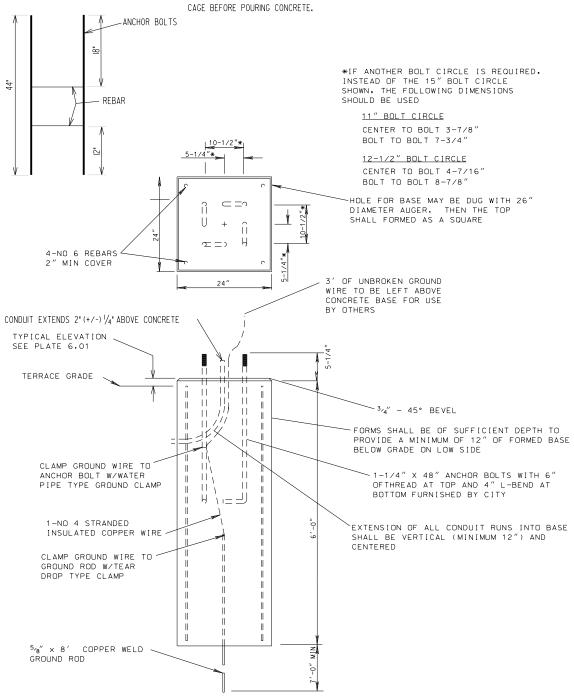

DETAIL: TYPE LB-8 BASE

SCALE: NONE

FILE NAME: \$\$....designfile....\$\$

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AY SHEET NO. C SIGNAL E-8

ELECTRICAL PLANS

MISC. QTY. CITY OF MADISON

JLS 6/28/2018
REV. JLS 8-30-18
REV. JLS 9-14-18

ELECTRICAL HANDHOLES (45865)

60427 60702 60706 60708

REMOVE CONSTRUCT CONSTRUCT CONSTRUCT

ELECTRICAL ELECTRICAL ELECTRICAL

HANDHOLE HANDHOLE TYPE I HANDHOLE TYPE V HANDHOLE TYPE VII

				II/ (INDITIOEL		V II		
CATEGORY D	ESCRIPTION	STATION	OFFSET	EACH	EACH	EACH	EACH	COMMENTS
0030/0040	HH1	11+48.8	90' R	-	-	-	-	[REMOVED ITEM]
	HH2	11+93.4	95' R	-	-	-	-	MAINTAIN EXISTING HANDHOLE
	HH3	12+44.8	94' R	-	-	-	-	MAINTAIN EXISTING HANDHOLE
	HH4	12+60.4	19' R	-	-	-	-	[ADJUST INLET]
	HH5	12+67	23' R	-	1	-	-	[CHANGED TYPE V TO TYPE I]
	HH6	12+68.3	46' L	-	-	1	-	
	11117	10 : 64 0	47 CLI	1				DEMOVE DELOCATE

HH1 was removed, Type VII added to HH13

60241

12+64.2 HH7 47.6' L REMOVE, RELOCATE HH8 12+44.4 60' L INTERCEPT EXISTING CONDUITS HH9 12+04.8 57' L MAINTAIN EXISTING HANDHOLE HH10 11+46.8 60.5' L MAINTAIN EXISTING HANDHOLE HH11 11+51 33' L [REMOVED ITEM] 5' R HH12 11+29.6 MAINTAIN EXISTING HANDHOLE 1 1 73' R HH13 11+29.0 MAINTAIN EXISTING HANDHOLE HH14 11+33.7 6.5' R 1 [ADD TYPE I HH] PROJECT 45865 TOTALS 2 2 1

TRAFFIC SIGNAL CONDUIT (45865)

60229

60231

60232

FURNISH AND	INSTALL
60224	60225

			CONDUIT BY OPEN TRENCH	CONDUIT) 3 INCH PVC (SCH 40) : CONDUIT BY OPEN TRENCH	CONDUIT	CONDUIT BY OPEN TRENCH	CONDUIT BY OPEN TRENCH	CONDUIT BY OPEN TRENCH	CONDUIT	FOR ELECTRICAL CONDUIT OR CABLE-IN-DUC	
CATEGORY	FROM	TO	LF	LF	LF	LF	LF	LF	LF	LF	L.F	COMMENTS
0040 TC1 TC1 HH2		HH13	-	-	30	30	-	-	-	-	-	(2) - 3"
		TS1	-	-	15	-	-	-	-	-	-	(1) - 3"
		TS2	-	-	-	-	-	-	8	-	-	(1) - 2"
	HH3	TS3	-	-	-	-	-	-	8	-	-	(1) - 2"
	HH3	TS4	=	=	40	=	=	=	=	=	-	(1) - 3"
	HH5	HH4	12	-	6	-	12	-	=	-	-	MATCH EXISTING CONDUIT
	HH5	EXISTING SL	-	-	-	=	12	-	=	-	-	MATCH EXISTING CONDUIT
	HH6	EXISTING	7	-	-	-	6	-	-	-	-	(1) - 3"
	HH6	TS5	-	-	5	-	-	-	-	-	-	(1) - 2"
	HH6	HH8	-	-	28	-	-	-	-	-	-	(1) - 3"
	HH8	TS6	-	-	12	-	-	-	-	-	-	(1) - 3"
	HH9	TS7	-	-	-	-	-	-	6	-	-	(1) - 2"
	HH10	TS8	-	-	14	-	-	-	-	-	-	(1) - 3"
	TS9	EXISTING	_	-	12	_	_	-	=	-	-	MATCH EXISTING CONDUIT
	HH13	EXISTING	-	-	-	-	6	-	-	-	-	MATCH EXISTING CONDUI
	HH13	SL7519	-	-	4	=	-	-	=	=	-	(1) - 3"
	HH13	TS10	-	-	-	-	_	-	12	-	-	(1) - 2"
		TRIBUTED	-	-	-	-	_	=	=	=	65	UNDISTRIBUTED
Е		EXISTING SL	_	-	-	_	_	-	8	-	-	
	HH5	SL7520	-	-	6	-	-	-	=	-	-	
	TS4	TS11	-	-	-	-	-	-	14	-		(1) - 2"
	HH12	HH14	-	-	-	10	-	-	-	-	-	(1) - 3"
DDO IE	CT 45865 T	OTAL C	19	0	172	40	36	0	56	0	65	

60221

60222

60223

MISC. QTY.

SHEET NO. E-9

ELECTRICAL PLANS

CITY OF MADISON

JLS 6/28/2018 REV. JLS 8-30-18 REV. JLS 9-14-18

TRAFFIC SIGNAL BASES (45865)

CATEGORY	DESCRIPTION	STATION	OFFSET	60413 CONCRETE BASE TYPE P EACH	60411 CONCRETE BASE TYPE G EACH	60403 CONCRETE BASE TYPE LB-3 EACH	60407 CONCRETE BASE TYPE LB-8 EACH	60409 CONSTRUCTION OFFSET BASE EACH	60421 REMOVE STREET LIGHT BASE EACH	90100 CONCRETE BASES TYPE 10 EACH	90101 REMOVE SIGN BASE EACH	COMMENTS
0100	TC1	11+48.8	95' R	1	-	-	-	_	-	-	-	
	TS1	11+50.4	85' R	-	-	-	1	-	-	-	-	
	TS2	11+93.6	85.6' R	-	-	-	1	-	-	-	-	
	TS3	12+45.5	86' R	-	1	-	-	-	-	-	-	
	TS4	12+62.4	70' R	-	-	-	-	-	-	1	-	
	SL7520	12+69.4	50' R	-	-	-	-	-	-	-	-	
	TS5	12+64.2	47.5' R	-	1	-	-	-	-	-	-	
	TS6	12+53.2	54' L	-	-	-	1	-	-	-	-	
	TS7	12+05.0	51' L	-	-	-	1	-	-	-	-	
	TS8	11+53.0	48.7' L	-	-	1	-	-	-	-	-	
	TS9	11+37.4	34' L	-	-	-	-	-	-	1	-	
	SL7519	11+35.9	5.1' R	-	-	1	-	-	1	-	-	
	TS10	11+39.2	75.7'R	-	1	-	-	-	-	-	<u>-</u>	
	TS11	12+63.1	77.5' R	-	1	-	-	-	-	-	-	
	UNDISTRIBUTED			-	-	1	-	1	1	-	5	UNDISTRIBUTED
	_	PROJECT 45	865 TOTALS	1	4	3	4	1	2	2	5	

SCALE: 1" = 30' REMOVE 8 FT -REMOVE 18 FT (TYP)

45865 AMERICAN PARKWAY AMERICAN FAMILY DRIVE TRAFFIC SIGNAL

PAVEMENT MARKING PLAN

AMERICAN FAMILY DRIVE AMERICAN PARKWAY

CITY OF MADISON

JLS 6/25/18

SHEET NO.

LEGEND

- (A) CROSSWALK, 6-INCH
- (B) STOP LINE, 24-INCH
- (C) SYMBOL, LEFT ARROW
- D SYMBOL, RIGHT ARROW
- (E) WORD, ONLY
- (F) RADIUS LINE, 4-INCH (5' LINE, 5' GAP)
- G PAVEMENT MARKING REMOVAL, 24-INCH
- PAVEMENT MARKING REMOVAL, 4-INCH

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45865 AMERICAN PARKWAY AMERICAN FAMILY DRIVE TRAFFIC SIGNAL


SHEET NO. L PM-2

PAVEMENT MARKING PLAN

AMERICAN PARKWAY AMERICAN FAMILY DRIVE

CITY OF MADISON

JLS 6/25/2018

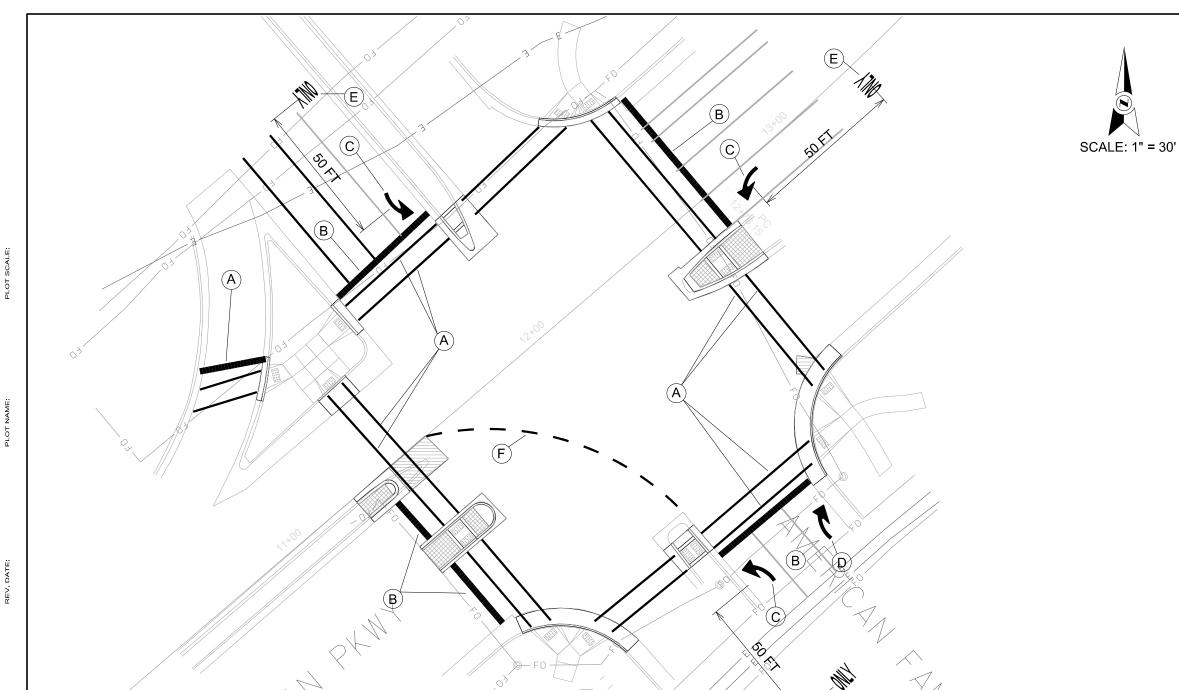

LEGEND

- (A) CROSSWALK, 6-INCH
- (B) STOP LINE, 24-INCH
- (C) SYMBOL, LEFT ARROW
- D SYMBOL, RIGHT ARROW
- E WORD, ONLY
- (F) RADIUS LINE, 4-INCH (5' LINE, 5' GAP)
- G PAVEMENT MARKING REMOVAL, 24-INCH
- PAVEMENT MARKING REMOVAL, 4-INCH

FILE NAME: \$\$....deslgnffle....\$\$
DATE: \$\$...plottlngdate...\$\$